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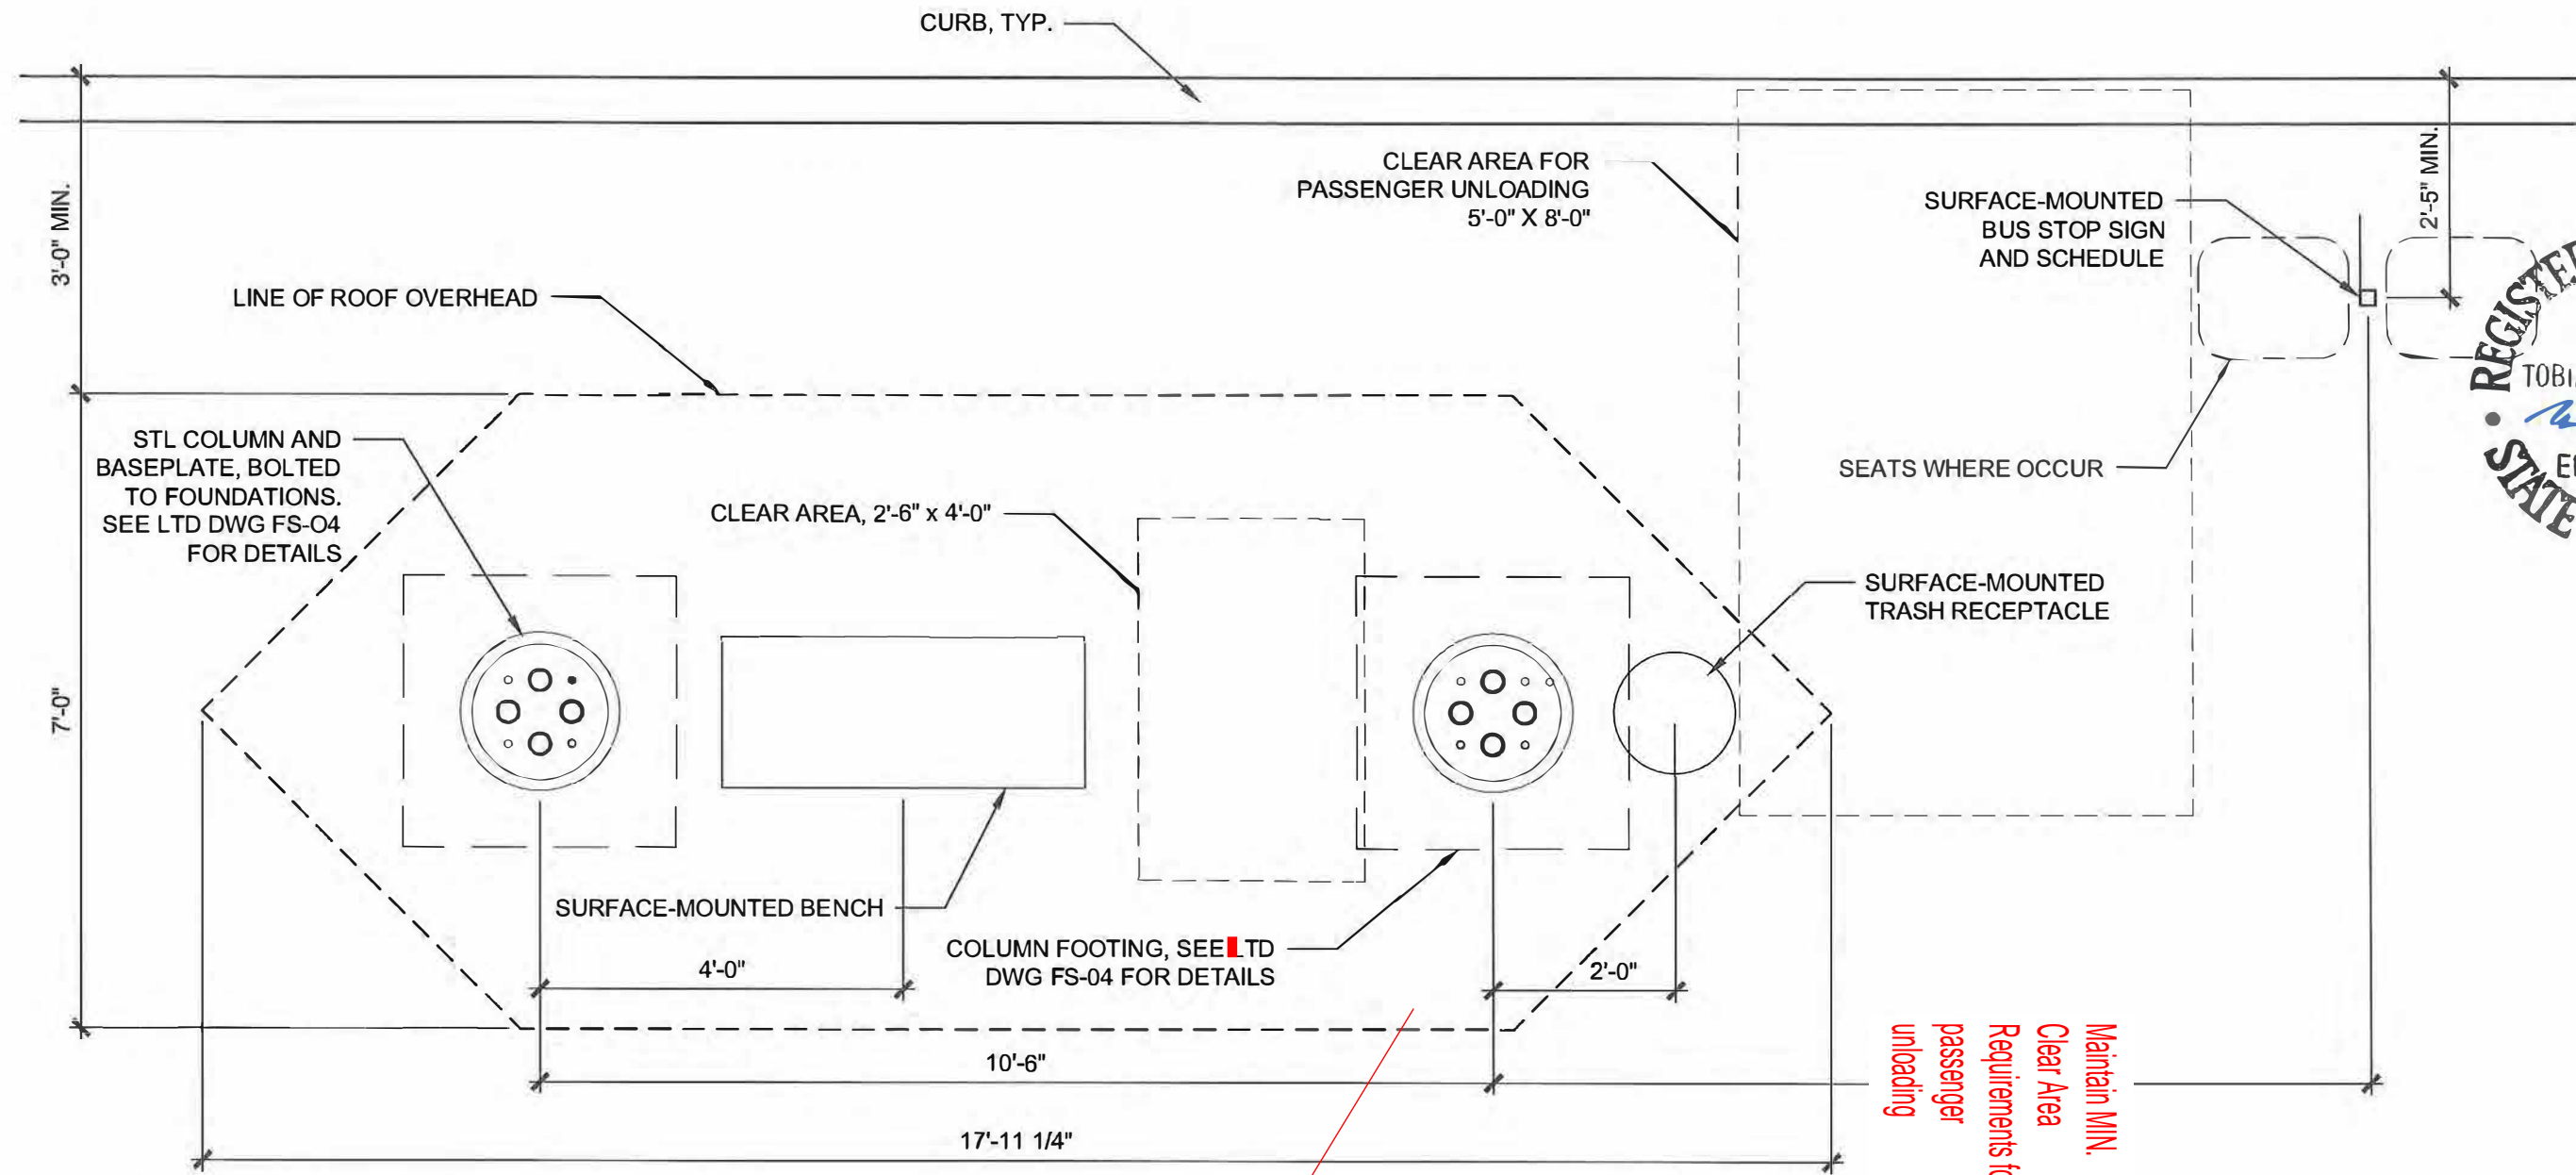
REGISTERED ARCHITECT
TOBIAS K. BARWOOD
EUGENE, OR
STATE OF OREGON



SITE PLAN - LTD TYPICAL BUS SHELTER
LANE TRANSIT DISTRICT
BUS STOP SHELTERS

PROJECT #: 1311
DATE: SEPTEMBER 6, 2013
DRAWN: KGT, ds
CHECK: TKB

A001



1 TYPICAL SITE PLAN - BUS STOP SHELTER

1/2" = 1'-0"

GENERAL NOTES

- A. CONCRETE:
MINIMUM 3000 PSI, AIR-ENTRAINED WITH LIGHT BROOM FINISH. MATCH EXISTING SLOPE W/ MAXIMUM SLOPE NOT TO EXCEED 2%. PROVIDE SCORE JOINTS IN NEW CONC. SLABS ALIGNED W/ EXISTING JOINTS OR AT 6'-0" MAXIMUM SPACING.
- B. PROVIDE TREE PROTECTION WHEN WORK IS ADJACENT TO EXISTING TREES. CONSULT OWNER OR ARCHITECT IF ROOTS LARER THAN 1 1/2" ARE ENCOUNTERED DURING EXCAVATION.

